BLUELINE

25 CENTRAL WAY, SUITE 400. KIRKLAND, WA 98033 P: 425.216.4051 F: 425.216.4052 WWW.THEBLUELINEGROUP.COM

AS NOTED PROJECT MANAGER:

BRETT K. PUDISTS, PE PROJECT ENGINEER. LYNDSEY MUNKEL, PE NADIA KROUMOVA

3/1/2019

GROSS FLOOR AREA: NUMBER OF LOTS PROPOSED: 14 PROPOSED USE: MINIMUM LOT SIZE ALLOWED: SETBACKS:


LOT COVERAGE:

BUILDING HEIGHT:

SINGLE FAMILY

8,400 SF FRONT 20' (F), REAR 25' (R), SIDE 5' (S) (BUT 2 SIDE YARDS MUST EQUAL 15") ROW AND VEHICULAR ACCESS EASEMENT 10 40% MAX (LOT SLOPE LESS THAN 15%) 30' MAX ABOVE ABE

SIZE AND MATERIAL IS ACCURATE. THE CONTRACTOR SHALL UNCOVER ALL INDICATED PIPING WHERE CROSSING, INTERFERENCES, OR CONNECTIONS OCCUR PRIOR TO TRENCHING OR EXCAVATION FOR ANY PIPE OR STRUCTURES, TO DETERMINE ACTUAL LOCATIONS, SIZE AND MATERIAL. THE CONTRACTOR SHALL MAKE THE APPROPRIATE PROVISION FOR PROTECTION OF SAID FACILITIES. THE CONTRACTOR SHALL NOTIFY <u>ONE CALL</u> AT 8-1-1 (WASHINGTON811.COM) AND ARRANGE FOR FIELD LOCATION OF EXISTING FACILITIES BEFORE CONSTRUCTION.

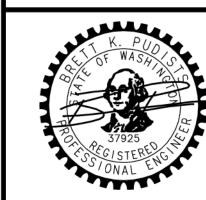

3/1/19 13-118

SHEET NAME: CV-01


₹ % ii © 2019 THE BLUELINE GROUP


✓ PIPE FLOW

]H[GATE VALVE

TEE W/ CONC BLOCKING

↓ BEND W/ CONC BLOCKIN

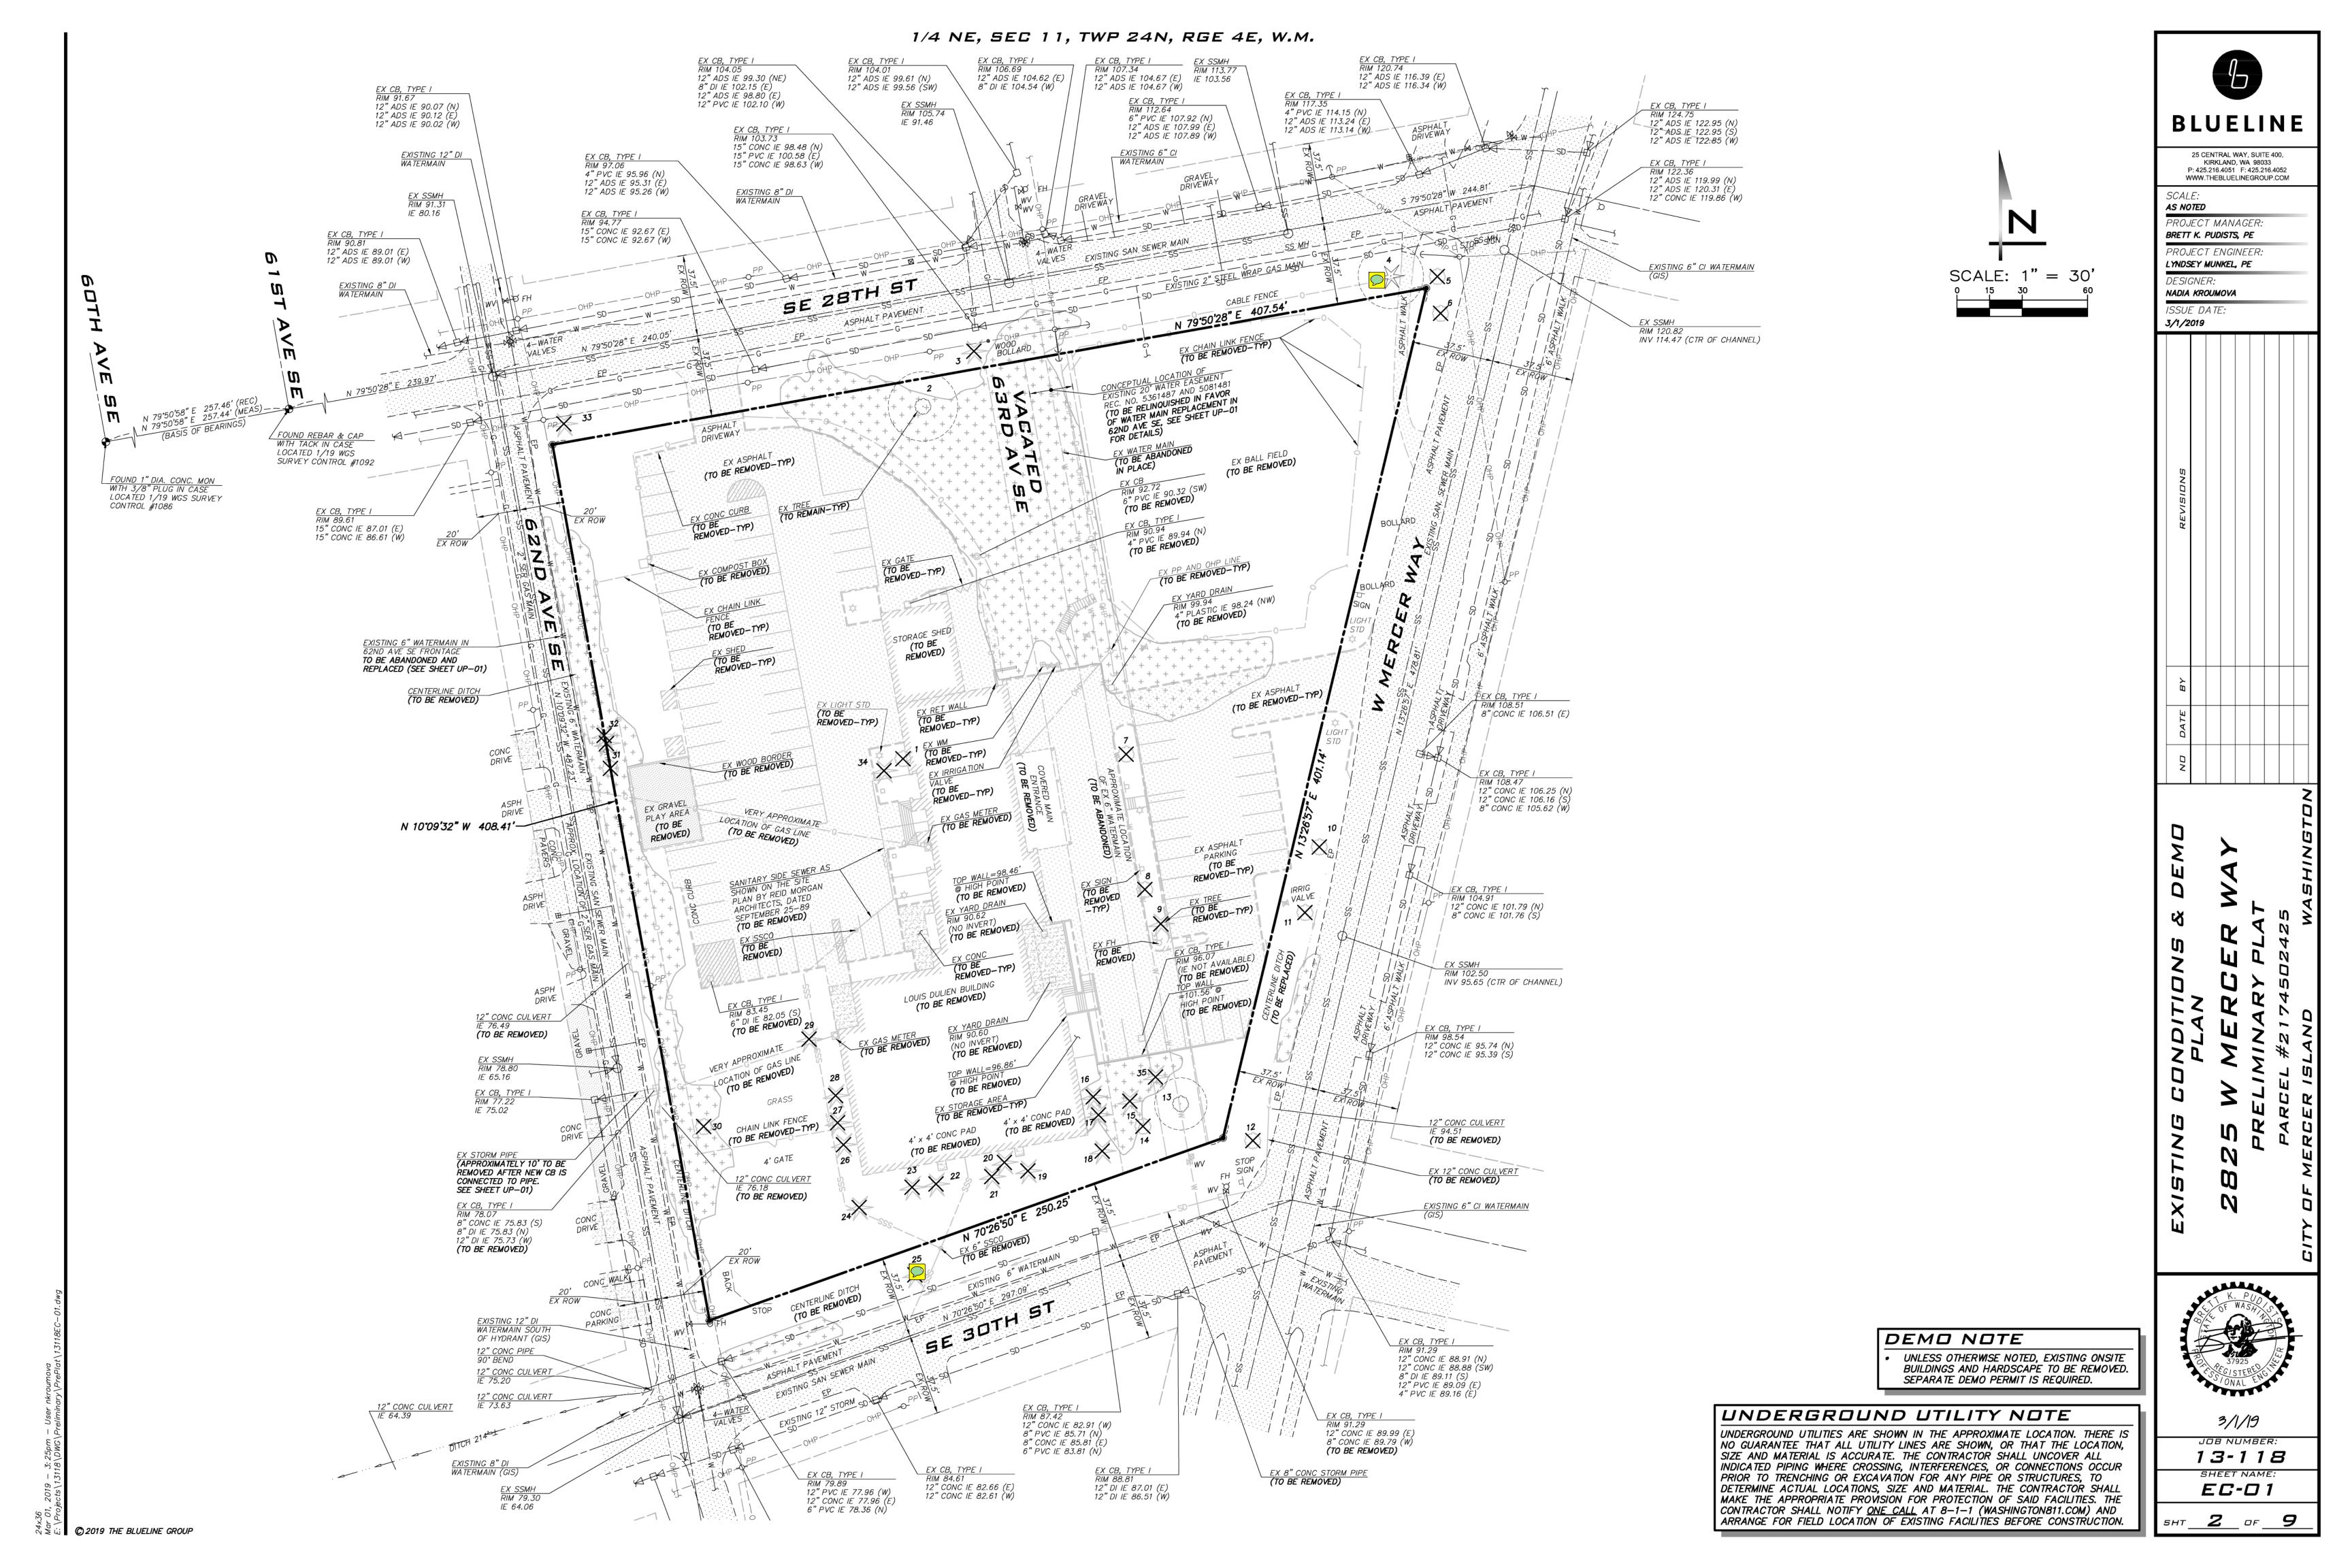

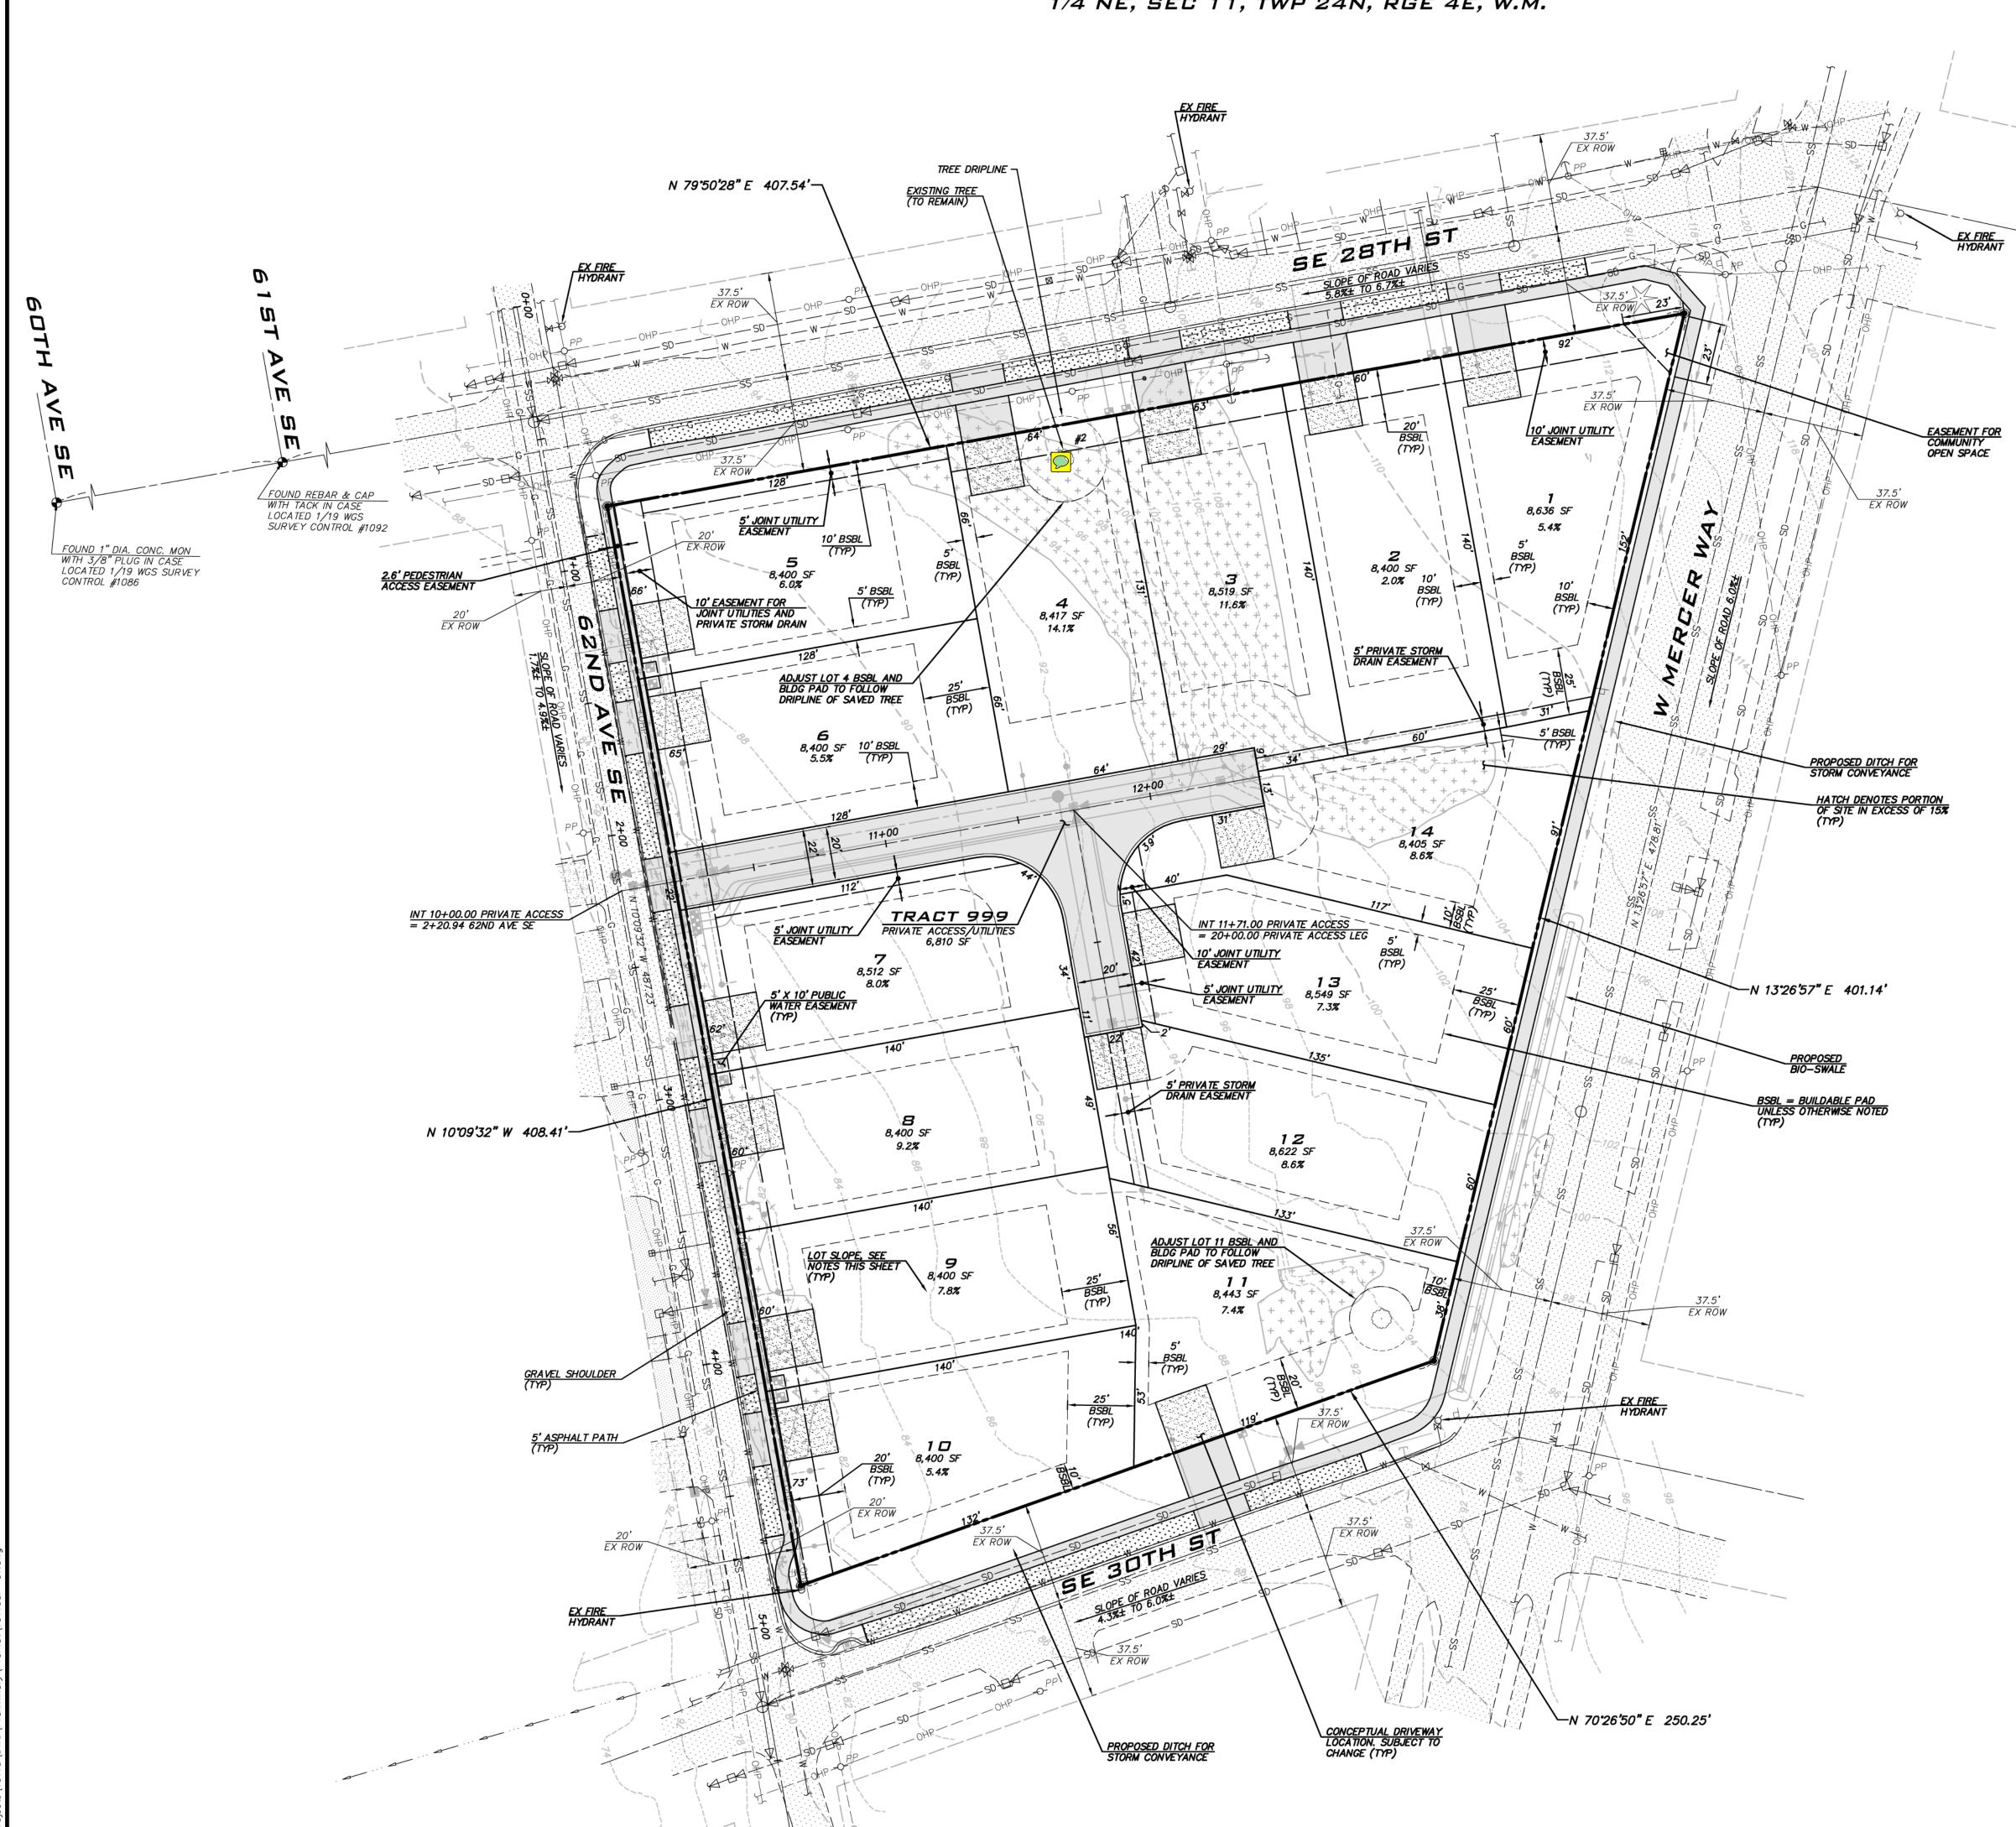

2019 THE BLUELINE GROUP




PROJECT MANAGER: BRETT K. PUDISTS, PE PROJECT ENGINEER: LYNDSEY MUNKEL, PE

NADIA KROUMOVA

3/1/2019

AS NOTED

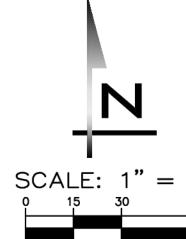

1	<u> </u>
SCALE:	1" =

LOT COVERAGE TABLE

LOT NO.	LOT AREA (SF)	LOT COVERAGE (SF)*	LANDSCAPING AREA (SF)*	PORTION OF LANDSCAPING AREA THAT CAN BE HARDSCAPE (SF)**		
	9.644	2.450	F 19C	, ,		
 	8,644	3,458	5,186	778		
2	8,400	3,360	5,040	756		
3	8,417	3,367	5,050	758		
4	8,417	3,367	5,050	758		
5	8,401	3,360	5,041	756		
6	8,530	3,412	5,118	768		
7	8,512	3,405	5,107	766		
8	8,400	3,360	5,040	756		
9	8,400	3,360	5,040	756		
10	8,403	3,361	5,042	756		
11	8,423	3,369	5,054	758		
12	8,639	3,456	5,183	778		
13	8,545	3,418	5,127	769		
14	8,441	3,376	5,065	760		
*LOT CO	JEDA CE LAC	OC THE LOT A	SEAN AND LANDS	CADING ADEA (COO) OF THE		

*LOT COVERAGE (40% OF THE LOT AREA) AND LANDSCAPING AREA (60% OF THE OT AREA) ARE BASED ON THE EXISTING SLOPE ACROSS THE LOT (<15%). EXCEPT WHERE USED FOR HARDSCAPE IMPROVEMENTS. 9% OF THE LOT AREA MAY CONSIST OF HARDSCAPE IMPROVEMENTS

FIRE SPRINKLERS

- NEW SINGLE FAMILY RESIDENCES REQUIRE A MINIMUM OF 13D SPRINKLER SYSTEM.

LOT SLOPES



DENOTES AREAS OF SLOPE ≥ 15%.

X.X**%** SLOPE OF LOT =

((HIGHEST LOT ELEVATION - LOWEST LOT ELEVATION) / HORIZONTAL DISTANCE) X 100

CRITICAL AREAS NOTE

NO CRITICAL AREAS WERE IDENTIFIED ON SITE.

NEAREST FIRE HYDRANT

EXISTING FIRE HYDRANTS ARE LOCATED NEAR EACH STREET INTERSECTION AND HAVE BEEN LABELED FOR CONVENIENCE.

BUILDING HEIGHTS

PROPOSED BUILDINGS WILL BE DESIGNED IN THE FUTURE AS PART OF THE BUILDING PERMIT PROCESS.

AVERAGE BUILDING ELEVATION GRADE POINTS TO BE


DETERMINED BASED ON PROPOSED BUILDINGS BY OTHERS.

NOTES

- SEE LEGEND ON SHEET CV-01.
- REFER TO SHEET EC-01 FOR EXISTING FEATURES THAT WILL BE REMOVED.
- REFER TO SHEET GP-01 FOR PRELIMINARY GRADING PLAN.
- REFER TO SHEET UP-01 FOR PRELIMINARY UTILITY PLAN.
- SEE SHEET RS-01 FOR ROAD SLOPES AND CROSS SECTIONS.
- SEE SHEET TR-01 FOR TREE NUMBERS AND RETENTION SUMMARY.
- DIRECT VEHICULAR ACCESS TO W MERCER WAY IS PROHIBITED.

UNDERGROUND UTILITY NOTE

UNDERGROUND UTILITIES ARE SHOWN IN THE APPROXIMATE LOCATION. THERE IS NO GUARANTEE THAT ALL UTILITY LINES ARE SHOWN, OR THAT THE LOCATION, SIZE AND MATERIAL IS ACCURATE. THE CONTRACTOR SHALL UNCOVER ALL INDICATED PIPING WHERE CROSSING, INTERFERENCES, OR CONNECTIONS OCCUR PRIOR TO TRENCHING OR EXCAVATION FOR ANY PIPE OR STRUCTURES, TO DETERMINE ACTUAL LOCATIONS, SIZE AND MATERIAL. THE CONTRACTOR SHALL MAKE THE APPROPRIATE PROVISION FOR PROTECTION OF SAID FACILITIES. THE CONTRACTOR SHALL NOTIFY ONE CALL AT 8-1-1 (WASHINGTON811.COM) AND ARRANGE FOR FIELD LOCATION OF EXISTING FACILITIES BEFORE CONSTRUCTION.

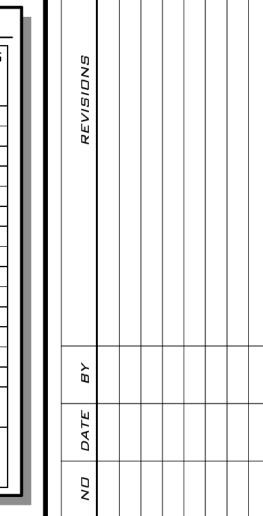




3/1/19

13-118 SHEET NAME: SP-01

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SCALE: AS NOTED

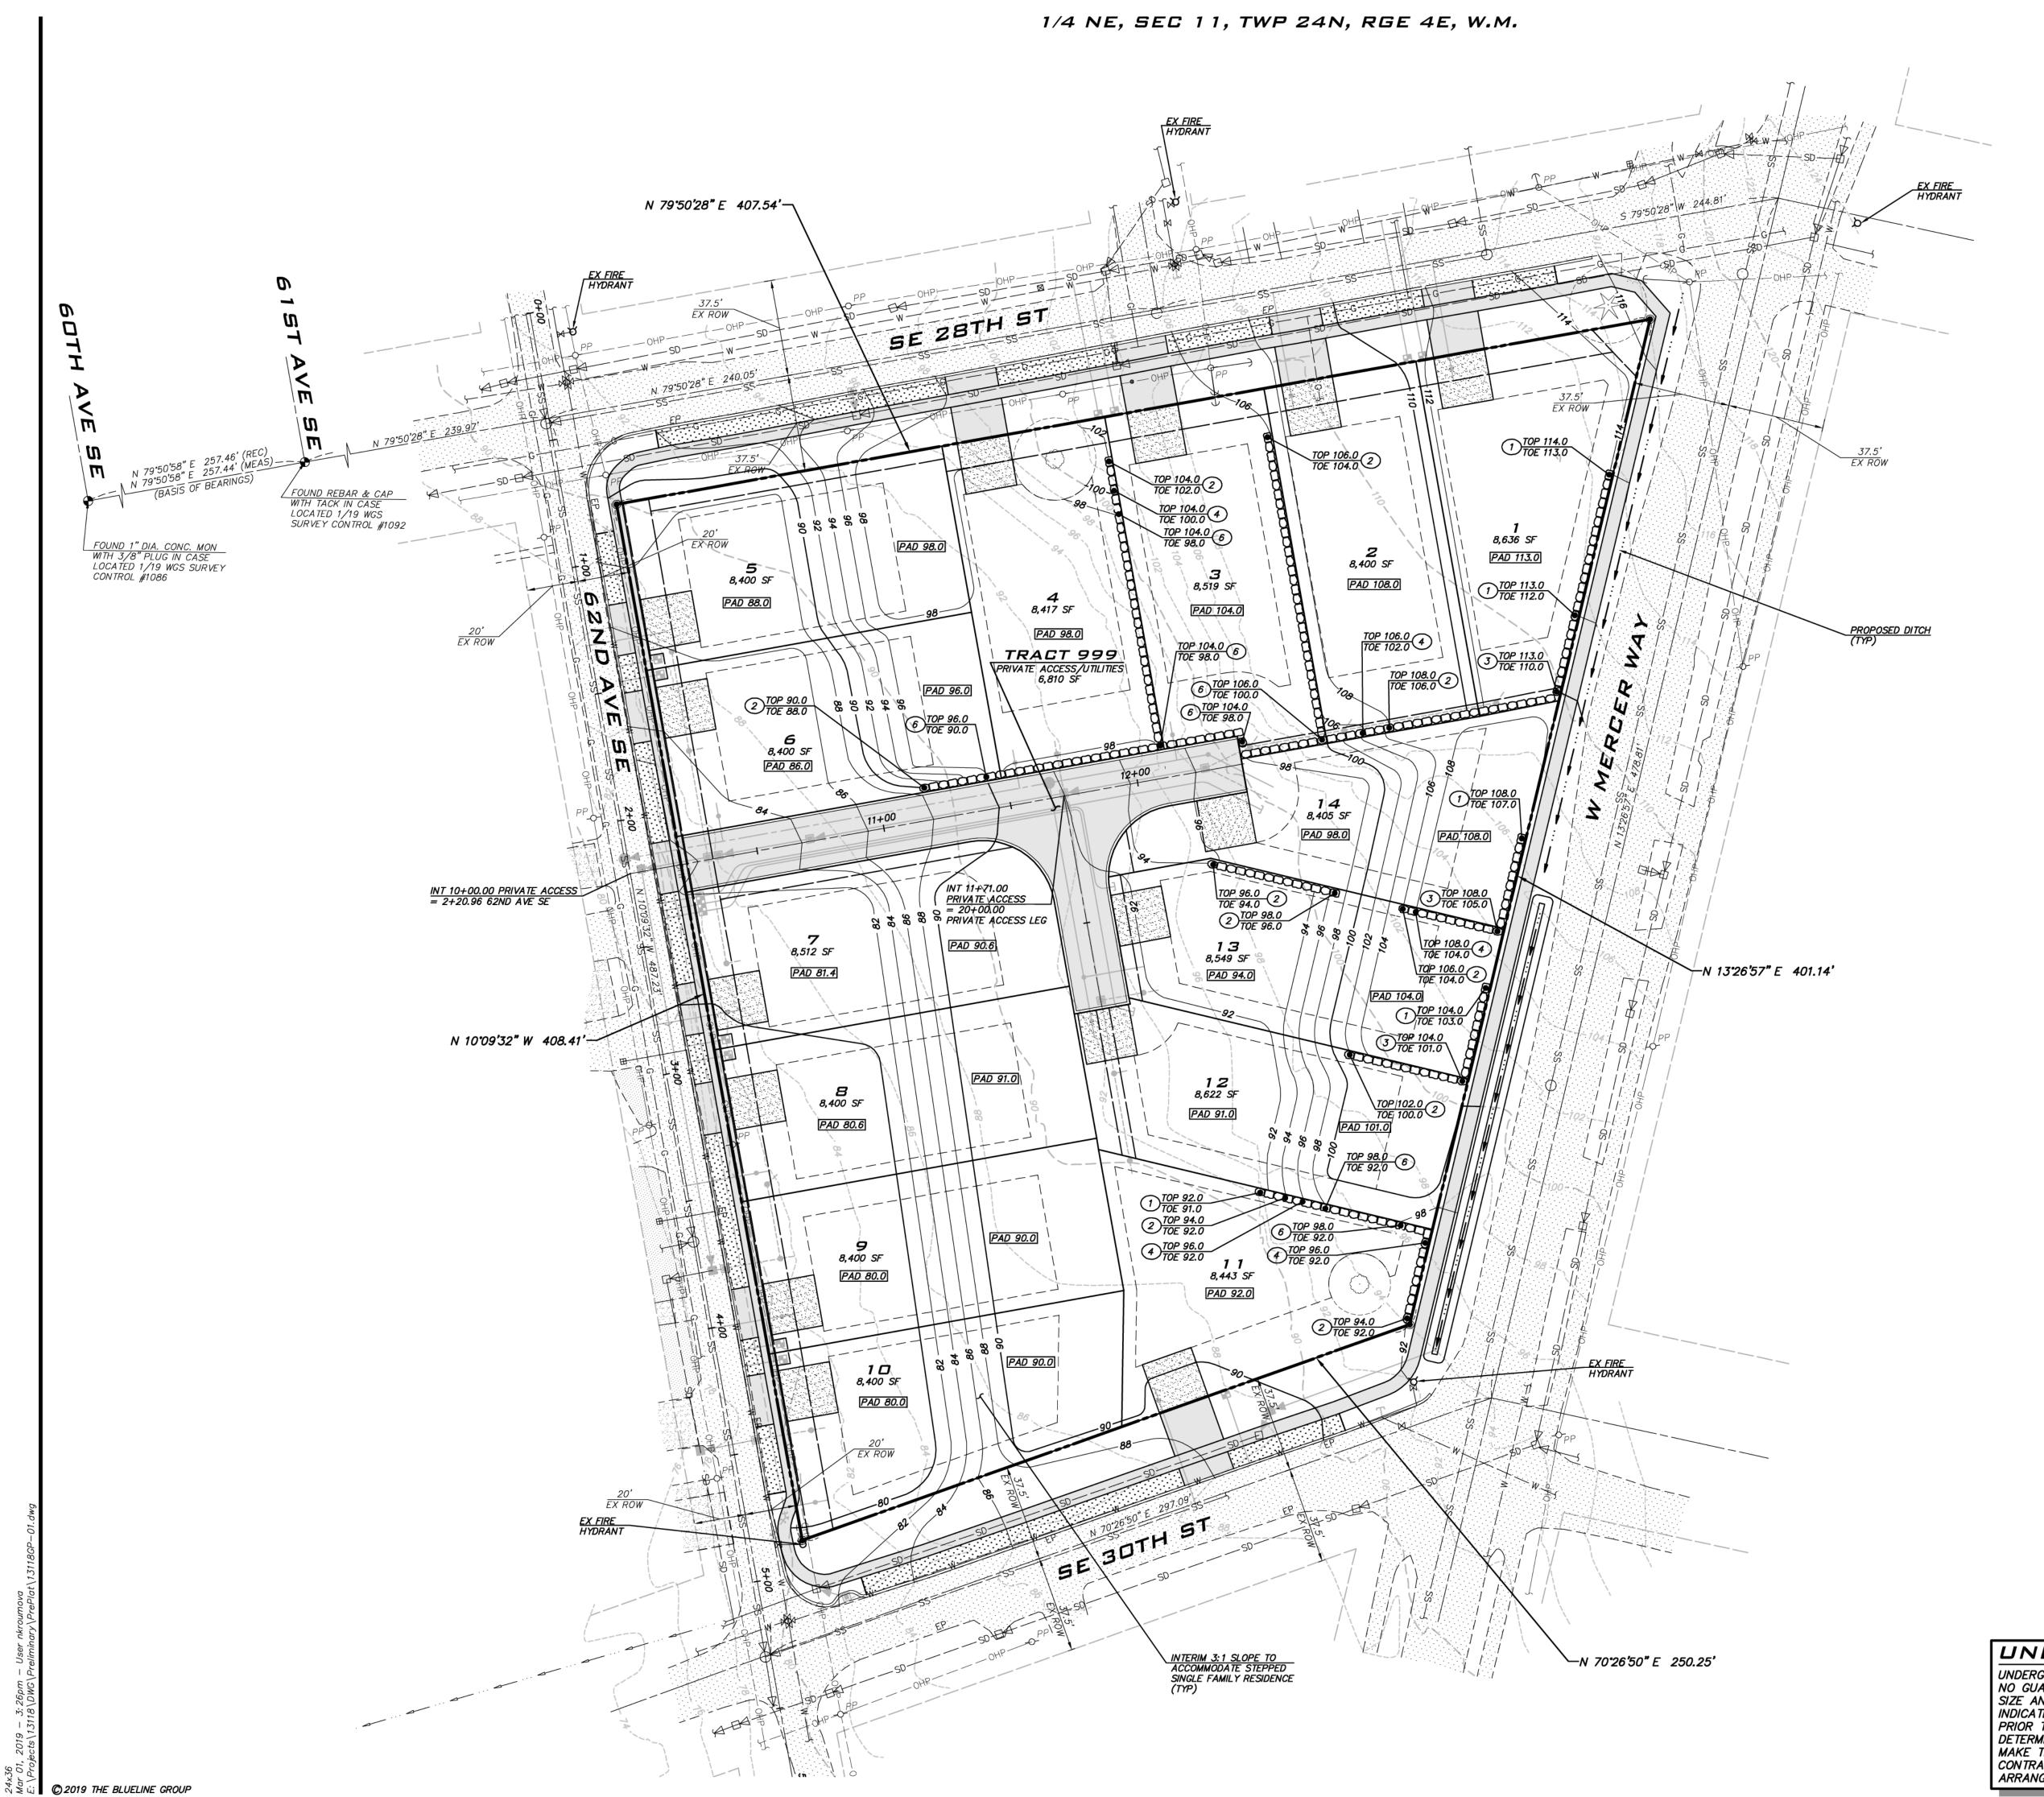PROJECT MANAGER: BRETT K. PUDISTS, PE

PROJECT ENGINEER: LYNDSEY MUNKEL, PE NADIA KROUMOVA

ISSUE DATE:

3/1/2019

- AS DESIGNED, NO AREAS EXCEED 6' OF CUT OR FILL.

PRELIMINARY EARTHWORK

NOTE: QUANTITIES ARE PRELIMINARY AND WERE CALCULATED BY

SUBTRACTING FINISHED GRADE FROM EXISTING GRADE.

PAD ELEVATIONS ARE APPROXIMATE AND WILL BE REFINED DURING FINAL DESIGN WHEN PROPOSED BUILDING PLANS ARE

TESC FACILITIES TO BE DESIGNED DURING FINAL ENGINEERING TO PREVENT SEDIMENT LADEN RUNOFF FROM LEAVING THE

UNDERGROUND UTILITY NOTE

6,877 CY 5,930 CY

NOTES

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13-118 SHEET NAME: GP-01

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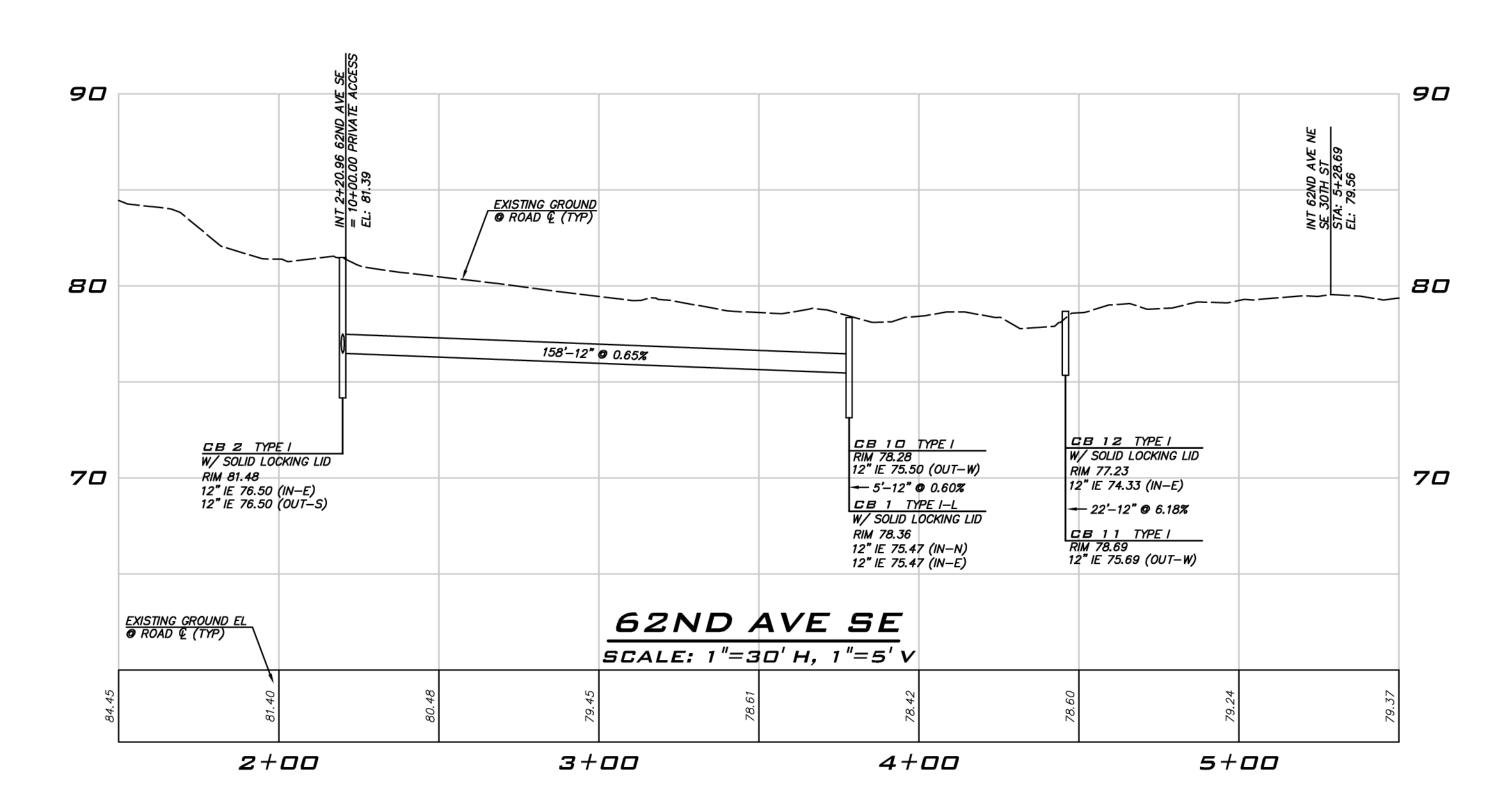
AS NOTED PROJECT MANAGER: BRETT K. PUDISTS, PE


LYNDSEY MUNKEL, PE NADIA KROUMOVA ISSUE DATE:


3/1/19

13-118 SHEET NAME: RS-01

<u>6</u> of 9



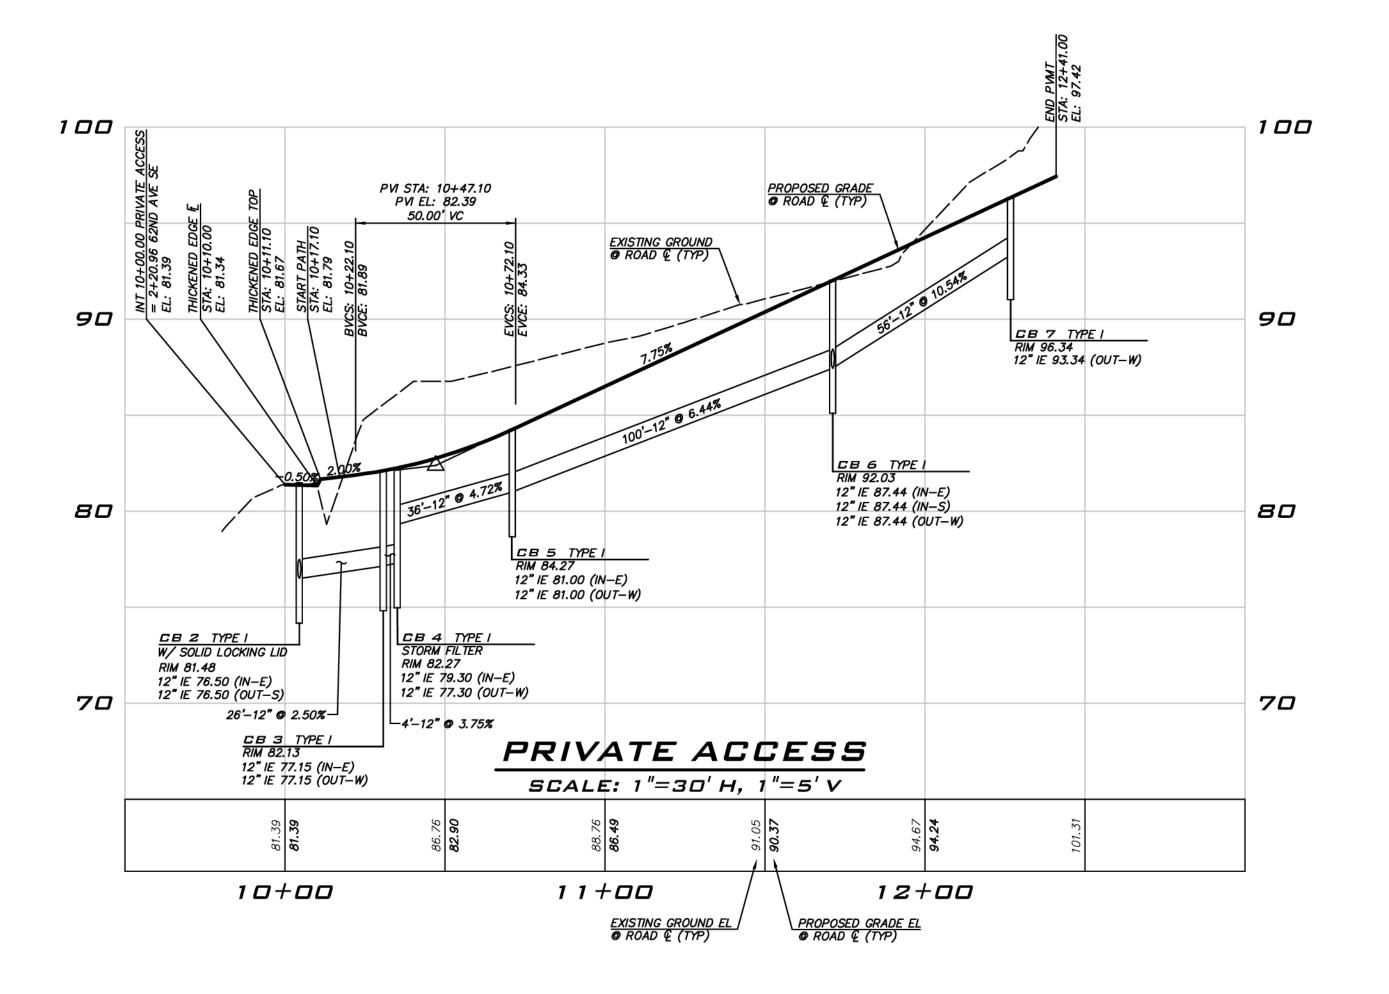

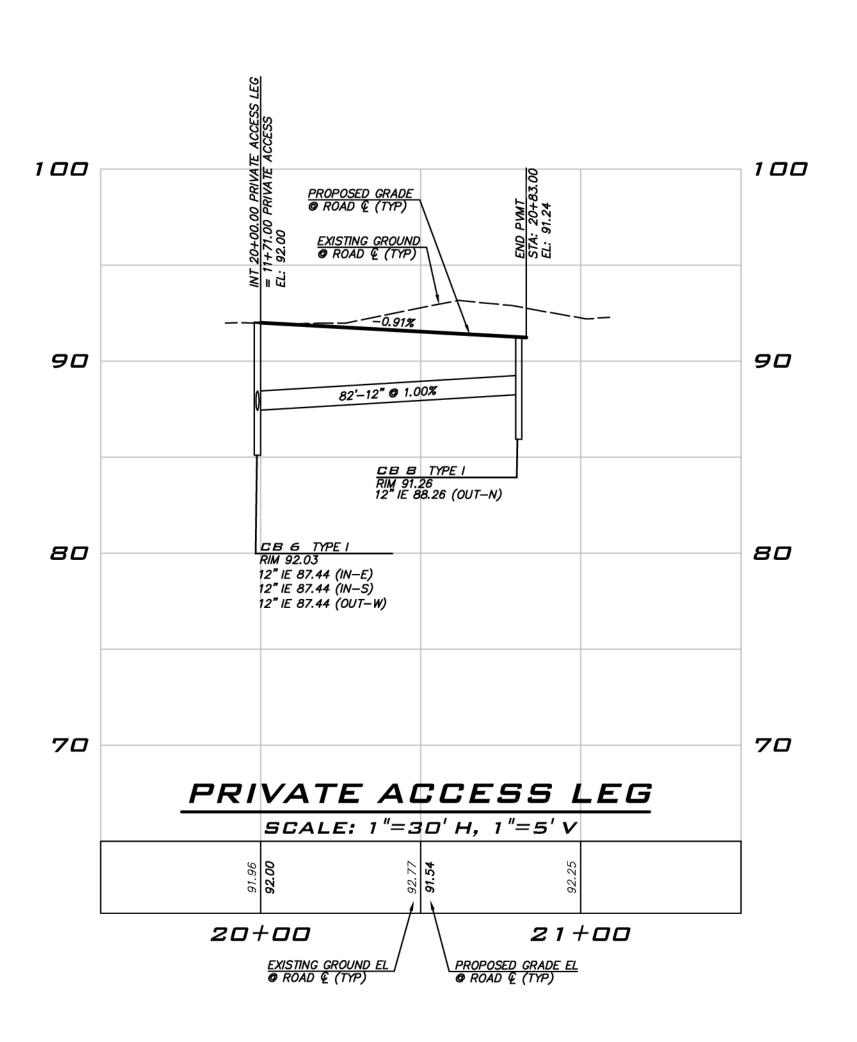

NOTE

NO DIRECT VEHICULAR ACCESS TO W MERCER WAY.

UNDERGROUND UTILITY NOTE

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SCALE: AS NOTED

PROJECT MANAGER: BRETT K. PUDISTS, PE

PROJECT ENGINEER:
LYNDSEY MUNKEL, PE

DESIGNER:
NADIA KROUMOVA

ISSUE DATE: 3/1/2019

/SIDNS

E BY REVISIONS

FILES
NO DATE B

VAY

5 W MERCER WA

X. PUD WASHING WASHING 37925 OF STERENCE

3/1/19

13-118 SHEET NAME: RP-01

7 of 9

BLUELINE

PROJECT MANAGER:

PROJECT ENGINEER: LYNDSEY MUNKEL, PE



3/1/19

13-118 SHEET NAME: TR-0 1

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Registered Consulting Arborist

Mike O'Brien, OB Mercer Island Properties RE: Arborist Report, 2825 West Mercer Way, Mercer Island WA February 21, 2019 Page 10 of 11

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Regulated Threshold	Regulated Category	> 24" DBH	Tree No.*	DBH (in.)	QMD	Common name/Latin name	Dripline Radius	Health	Structure	Comments on Condition	Tree Туре	Viable Tree?
NR			19	12"		Leyland cypress, Cupressus xLeylandii	16'	1	2		С	No
NR		Yes	20	28"		Leyland cypress, Cupressus xLeylandii	16'	1	2		С	No
NR		Yes	21	27"		Leyland cypress, Cupressus xLeylandii	16'	1	2		С	No
NR		Yes	22	34"		Leyland cypress, Cupressus xLeylandii	16'	1	2		С	No
NR			23	21"		Leyland cypress, Cupressus xLeylandii	16'	1	2		С	No
NR		Yes	24	26"		Leyland cypress, Cupressus xLeylandii	16'	1	2		С	No
NR		Yes	25	18,21"	27"	Leyland cypress, Cupressus xLeylandii	16'	1	1		С	Yes
NR		Yes	26	25"		Leyland cypress, Cupressus xLeylandii	16'	1	2		С	No
NR		Yes	27	24"		Leyland cypress, Cupressus xLeylandii	16'	1	2	Asymmetric (hedge against	С	No
NR		Yes	28	31"		Leyland cypress, Cupressus xLeylandii	16'	1	2	existing building)	С	No
NR			29	11"		Portugal laurel, Prunus Iusitanica	10'	1	1		BE	Yes
36"	Significant		30	8,8"	11"	Plum (seedling), Prunus domestica	15′	3	3	Diseased, topped, decay, lean	D	No
36"	Significant		31	14"		Pear, common, Pyrus communis	16'	2	3	Topped, covered in ivy	D	No
16"	Significant		32	8,8,8"	13"	English hawthorn, Crataegus monogyna	15'	2	3	Multiple Idrs, lean, ivy	D	No
NR			33	7,9"	11"	Portugal laurel, Prunus Iusitanica	12'	1	2	Double leader	BE	Yes

NR = Not Regulated Tree numbers are non-sequential because 3 small trees included in the previous inventory are removed from this report.

Registered Consulting Arborist

CITY OF MERCER ISLAND

S:\DSG\FORMS\2017 Forms\Trees\TreeInventory&Replacement

EXCEPTIONAL TREES

DEVELOPMENT SERVICES GROUP 9611 SE 36TH STREET | MERCER ISLAND, WA 98040

PHONE: 206.275.7605 | www.mercergov.org TREE INVENTORY & REPLACEMENT SUBMITTAL INFORMATION

value constitutes an import species, condition, cultural/ with a diameter of more th	tree or group of trees that because of its unique his ant community resource. A tree that is rare or ex historical importance, age, and/or contribution a an 36 inches, or with a diameter that is equal to e Table shown in MICC 19.16 under Tree, Exceptio	ceptional by virtue of it s part of a tree grove. or greater than the dia	s size, Trees
List the total number of tree	s for each category and the tree identification num	bers from the arborist r	eport.
Number of trees 36" or grea	ater	0	
List tree numbers:			
Number of trees 24" or grea	ater (including 36" or greater)	1	
List tree numbers: 2	,		
Number of trees from Except List tree numbers: 2, 4, 5	otional Tree Table (MICC 19.16)	3	
List tree flumbers.			
Large Regulated Trees- med	ans any tree with a diameter of 10 inches or more	and any tree that mee	ets the
<u>Large Regulated Trees</u> - med definition of an Exceptional Number of Large Regulated		, and any tree that mee	ets the
Large Regulated Trees- med definition of an Exceptional Number of Large Regulated List tree numbers: 1-6, 8-1	Trees on site		
Large Regulated Trees- med definition of an Exceptional Number of Large Regulated List tree numbers: 1-6, 8-1 Number of Large Regulated List tree numbers: 1, 3, 5,	Trees on site 14 32 Trees on site proposed for removal		(A)
Large Regulated Trees- med definition of an Exceptional Number of Large Regulated List tree numbers: 1-6, 8-1 Number of Large Regulated List tree numbers: 1, 3, 5,	Trees on site 14 32 Trees on site proposed for removal 6, 8-12, 14, 30-32 etained ((A-B)/Ax100) note: must be at least 30%	16 13 19 dditional replacement trees	(A) (B) % have bee
Large Regulated Trees- med definition of an Exceptional Number of Large Regulated List tree numbers: 1-6, 8- Number of Large Regulated List tree numbers: 1, 3, 5, Percentage of trees to be re	Trees on site 14 32 Trees on site proposed for removal 6, 8-12, 14, 30-32 etained ((A-B)/Ax100) note: must be at least 30%	16 13 19 dditional replacement trees to used to offset lower percental	(A) (B) % have bee
Large Regulated Trees- med definition of an Exceptional Number of Large Regulated List tree numbers: 1-6, 8- Number of Large Regulated List tree numbers: 1, 3, 5, Percentage of trees to be re	Trees on site 14 32 Trees on site proposed for removal 6, 8-12, 14, 30-32 etained ((A-B)/Ax100) note: must be at least 30% *4 a include in the street right of way adjoint at tree that is located in the street right of way adjoint.	16 13 19 dditional replacement trees to used to offset lower percental	(A) (B) % have bee
Large Regulated Trees- med definition of an Exceptional Number of Large Regulated List tree numbers: 1-6, 8- Number of Large Regulated List tree numbers: 1, 3, 5, Percentage of trees to be resulted RIGHT OF WAY TREES Right of Way Trees- means of the Number of Large Regulated	Trees on site 14 32 Trees on site proposed for removal 6, 8-12, 14, 30-32 etained ((A-B)/Ax100) note: must be at least 30% *4 a include in the street right of way adjoint at tree that is located in the street right of way adjoint.		(A) (B) % have bee

Updated 11/29/2017

Page | 1

List tree numbers: 3, 5, 6, 10-12, 31, 32

Reason for removal: 3, 10-12 — diseased; 5 — overmature & non-viable; 31 & 32 — covered in ivy & non-viable

TREE REPLACEMENT

Tree replacement- removed trees must be replaced based on the ratio in the table below. Replacement trees shall be conifers at least six feet tall and or deciduous at least one and one-half inches in diameter at

			Number of Tree
	Tree	Number of	Required for
Diameter of Removed Tree (measured 4.5'	replacement	Trees Proposed	Replacement Based
above ground)	Ratio	for Removal	on Size/Type
Less than 10"	1	4	4
10" up to 24"	2	12	24
Greater than 24" up to 36"	3	0	0
Greater than 36" and any Exceptional Tree	6	1	6

38 - provided (to offset lower

TOTAL TREE REPLACEMENTS 34 - required

retention percentage)

S:\DSG\FORMS\2017 Forms\Trees\TreeInventory&Replacement

Updated 11/29/2017

Page | 2

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PROJECT ENGINEER: LYNDSEY MUNKEL, PE

NADIA KROUMOVA

3/1/2019

3/1/19

13-118 SHEET NAME: TR-02